# **<u>Cedar Street Pump Station Rehabilitation</u>**

ADDENDUM NO. 3 July 21, 2023

### THIS IS AN ADDENDUM

## TO PROSPECTIVE BIDDERS AND OTHERS CONCERNED:

This addendum amends or supplements the Procurement Section, Drawings and other provisions of the Contract Documents as indicated below. All provisions which are not so amended or supplemented remain in full force and effect.

The terms used in this Addendum have the meanings stated in the General Conditions. Additional terms used in this Addendum have the meanings stated below, which are applicable to both the singular and plural thereof.

## I. DRAWINGS

- A. Replace the following plan sheets:
  - i. A1.1, A3.1, A4.1, A4.2, A5.1, and A8.1
    - 1. Keynotes 051209, 040111, 230014, 233102, and 23314 were revised to clarify work.
    - 2. Water repellent keynote added to exterior elevations.
    - 3. Steel lintel keynote added.
    - 4. Tuck pointing was revised to cover the entire building instead of select areas. Total area is approximately 5,200 SF.
    - 5. Roof repair detail for chimney removal added.

## II. CONTRACT DOCUMENTS

- A. The drain elevation will be increased to go through the window. Anticipated elevation change is 2ft-increase in height. Revised drawings will be issued post bid to cover this change in elevation, but bids should cover the scope change. Insulated panel enclosure. Shorten up the keel wall window at that location.
- B. Add an 8-port ethernet switch at the existing PLC panel.


Prospective bidders shall attach this Addendum page to their proposal and shall sign the Addendum and submit same with bid and shall enter Addendum Number and date on the Bid Form. Failure to include signed Addendum with bid proposal shall be cause for rejection of bid.


(Bidder)

By: \_\_\_\_\_

Date: \_\_\_\_\_

Title:

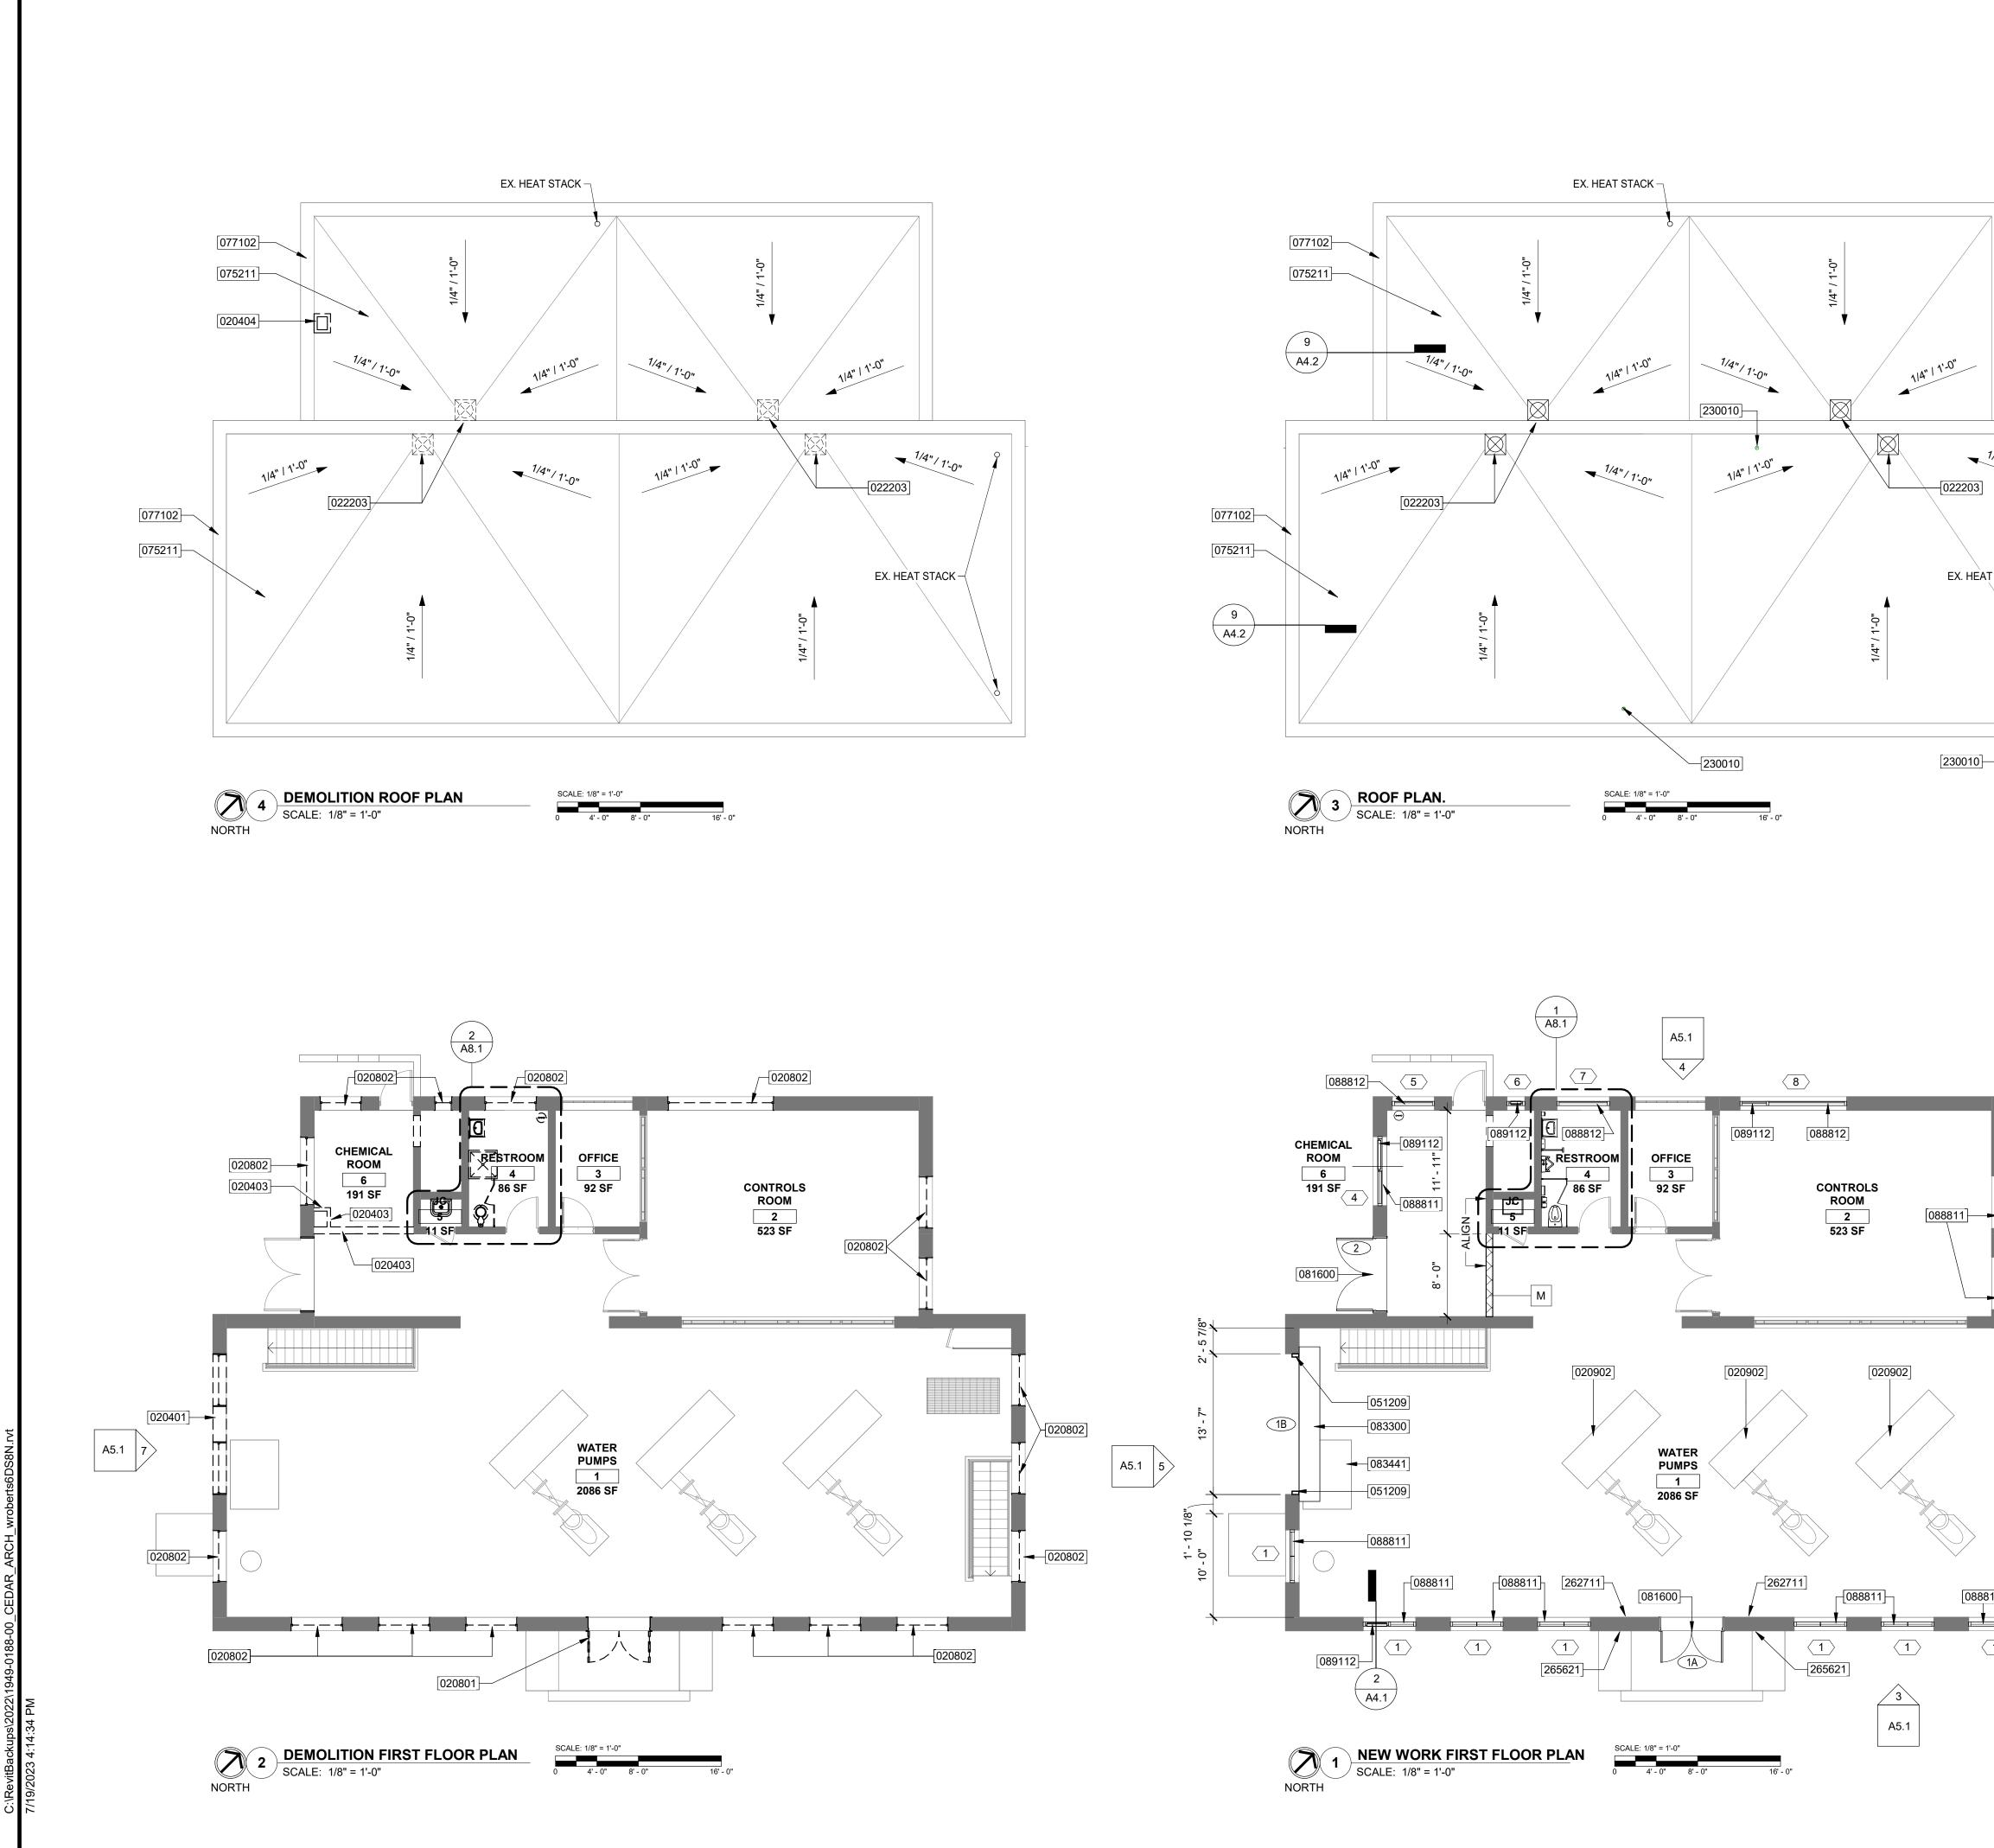


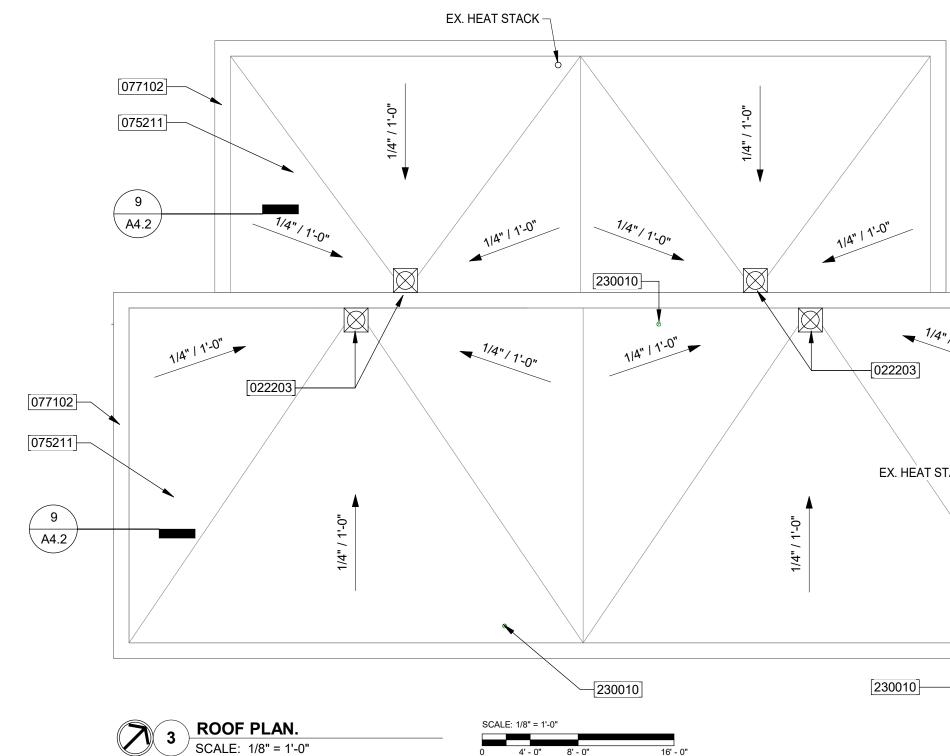



	<ul> <li><b>CENNERAL NOTES:</b></li> <li>A. REFER TO G-002 PROJECT GENERAL NOTES FOR ADDITIONAL INFORMATION.</li> <li>A. REFER TO PROJECT MANUAL FOR ADDITIONAL REQUIREMENTS.</li> <li>FIELD VERIFY ALL DOOR DIMENSIONS.</li> <li>EXPOSED STRUCTURAL STEEL, METAL DECK, AND PRE-CAST CONCRETE SHALL BE PAINTED.</li> <li>D. EXPOSED DUCTWORK, PIPING AND CONDUIT SHALL BE PAINTED.</li> </ul>	Know what's <b>below</b> Call before you dig MISS DIG System, Inc. 1-800-482-7171 www.missdig.org	INNOVATIVE IDEAS EXCEPTIONAL DESIGN UNMATCHED CLIENT SERVICE
1/4*/1:0* D3 HEAT STACK	<ul> <li>KEYNOTES</li> <li>020401 REMOVE EXISTING MASONRY</li> <li>020403 REMOVE EXISTING MASONRY INTERIOR WALL</li> <li>020404 REMOVE EXISTING CHIMNEY AND CAP OPENING</li> <li>020801 REMOVE EXISTING FRP DOOR AND FRAME</li> <li>020802 REMOVE EXISTING WINDOW INFILL AND FRAME</li> <li>020902 REMOVE EXISTING PUMP BASE AND INSTALL NEW FLOOR TILE TO MATCH ADJACENT SURFACES.</li> <li>022203 REMOVE AND REINSTALL EXISTING ROOF DRAIN WITH NEW ROOFING SYSTEM</li> <li>051209 HSS 8X4X3/8 JAMB WITH 1/2" BASE PLATE AND 2.1/2" DIA X 6" EMBED ADHESIVE ANCHORS</li> <li>075211 REMOVE EXISTING ROOFING SYSTEM, PREPARE SUBSTRATE FOR RE-ROOFING INSTALL NEW POLYISOCYANURATE INSULATION, 1/2" COVER BOARD AND 2-PLY MODIFED BITUMEN ROOFING SYSTEM</li> <li>077102 NEW METAL COPING OVER EXISTING STONE CAP</li> <li>081600 NEW FRP DOOR AND FAME IN EXISTING OPENING, REFER TO DOOR AND FRAME SCHEDULE.</li> </ul>	3 FULL WORKING DAYS BEFORE YOU DIG CALL MI	ARCHITECTURE • ENGINEERING • PLANNING SURVEYING • CONSTRUCTION SERVICES
	<ul> <li>083300 COILING COUNTER DOOR, REFER TO DOOR AND FRAME SCHEDULE</li> <li>083441 REPLACE EXISTING HATCH. SEE MECHANICAL</li> <li>088811 STRUCTURED-POLYCARBONATE-PANEL AND FRAME. SEE SPEC. INSTALL IN EXISTING OPENING</li> <li>088812 SECURITY PANEL AND FRAME. SEE SPEC. INSTALL IN EXISTING OPENING</li> <li>089112 HALF OR FULL WIDTH LOUVERS WITH DAMPERS WITH OR WITHOUT EXHAUST FANS. SEE SPEC. AND SCHEDULE</li> <li>230010 EQUIPMENT FLUE</li> <li>262711 INSTALL CONDUIT FOR EXTERIOR WALL MOUNTED LIGHTING AND SEAL PENETRATION IN EXTERIOR WALL. SEE ELECTRICAL.</li> <li>265621 INSTALL EXTERIOR WALL MOUNTED LIGHT. SEE ELECTRICAL.</li> </ul>	PROJECT SPONSOR: CITY OF FLINT CEDAR STREET FLINT, MI 48503	NEW WORK COMPOSITE PLAN & ROOF PLAN CEDAR PUMP STATION GEDAR STREET
		MARK ISSUED F 1 ISSUED FOR BIDS DRAWN BY: DESIGN BY: CHECKED BY: DLZ JOB NUMBER: SHEET NEW WORK COMPOSI SHEET NO.	OR DATE 7/5/23 


						ROO	M FIN	ISH SC	HEDU	ILE				
		FLOORS		WALLS									ILING	
ROOM				NORTH		EAST		SOUTH		WEST				
NO.	ROOM NAME	MAT.	BASE	MAT.	FINISH	MAT.	FINISH	MAT.	FINISH	MAT.	FINISH	MAT.	FINISH	
1	WATER PUMPS	EXIST.	EXIST.	EXIST.	PT.	EXIST.	PT.	EXIST./CMU	PT.	EXIST.	PT.	EXIST.	PT.	
2	CONTROLS ROOM	EXIST.	EXIST.	EXIST.	PT.	EXIST.	PT.	EXIST.	PT.	EXIST.	PT.	EXIST.	PT.	
3	OFFICE	EXIST.	EXIST.	EXIST.	EXIST.	EXIST.	EXIST.	EXIST.	EXIST.	EXIST.	EXIST.	EXIST.	PT.	
4	RESTROOM	EXIST.	EXIST.	EXIST.	PT.	EXIST.	PT.	EXIST.	PT.	EXIST.	PT.	EXIST.	PT.	
5	JC	EXIST.	EXIST.	EXIST.	EXIST.	EXIST.	EXIST.	EXIST.	EXIST.	EXIST.	EXIST.	EXIST.	EXIST.	
6	CHEMICAL ROOM	EXIST.	EXIST.	EXIST./CMU	PT.	EXIST.	PT.	EXIST.	PT.	EXIST.	PT.	EXIST.	PT.	
7	BASEMENT	EXIST.	EXIST.	EXIST.	PT.	EXIST.	PT.	EXIST.	PT.	EXIST.	PT.	EXIST.	PT.	


	DOOR AND FRAME SCHEDULE												
	DOOR							DETAIL					
OPNG.			DOOR	DOOR		FRAME	FRAME	FRAME	FRAME	FRAME	FIRE		
NO.	WIDTH	HEIGHT	TYPE	MATERIAL	GLAZING	WIDTH	HEIGHT	DEPTH	TYPE	MATERIAL	RATING	HEAD	JAME
1A	6' - 0"	7' - 0"	В	FRP	-	2"	2"		1	STL		4/A4.1	5/A4.1
1B	13' - 7"	12' - 9"	A	STL	-	2"	2"		1	STL		1/A4.1	7/A4.1
2	7' - 0"	8' - 6"	В	FRP	-	2"	2"		1	STL		4/A4.1	5/A4.1

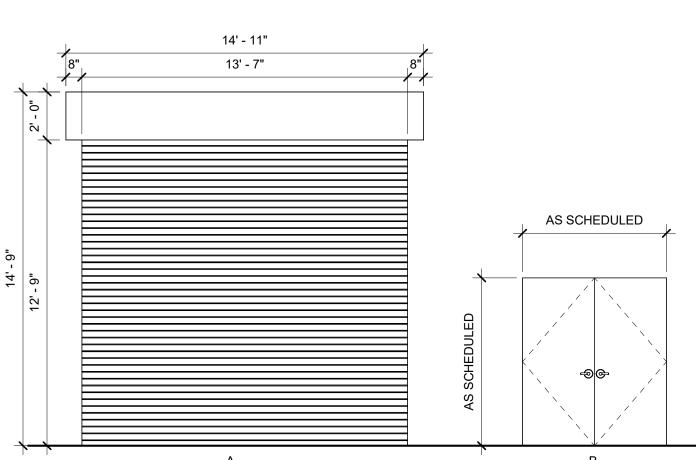

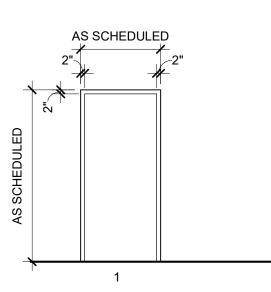


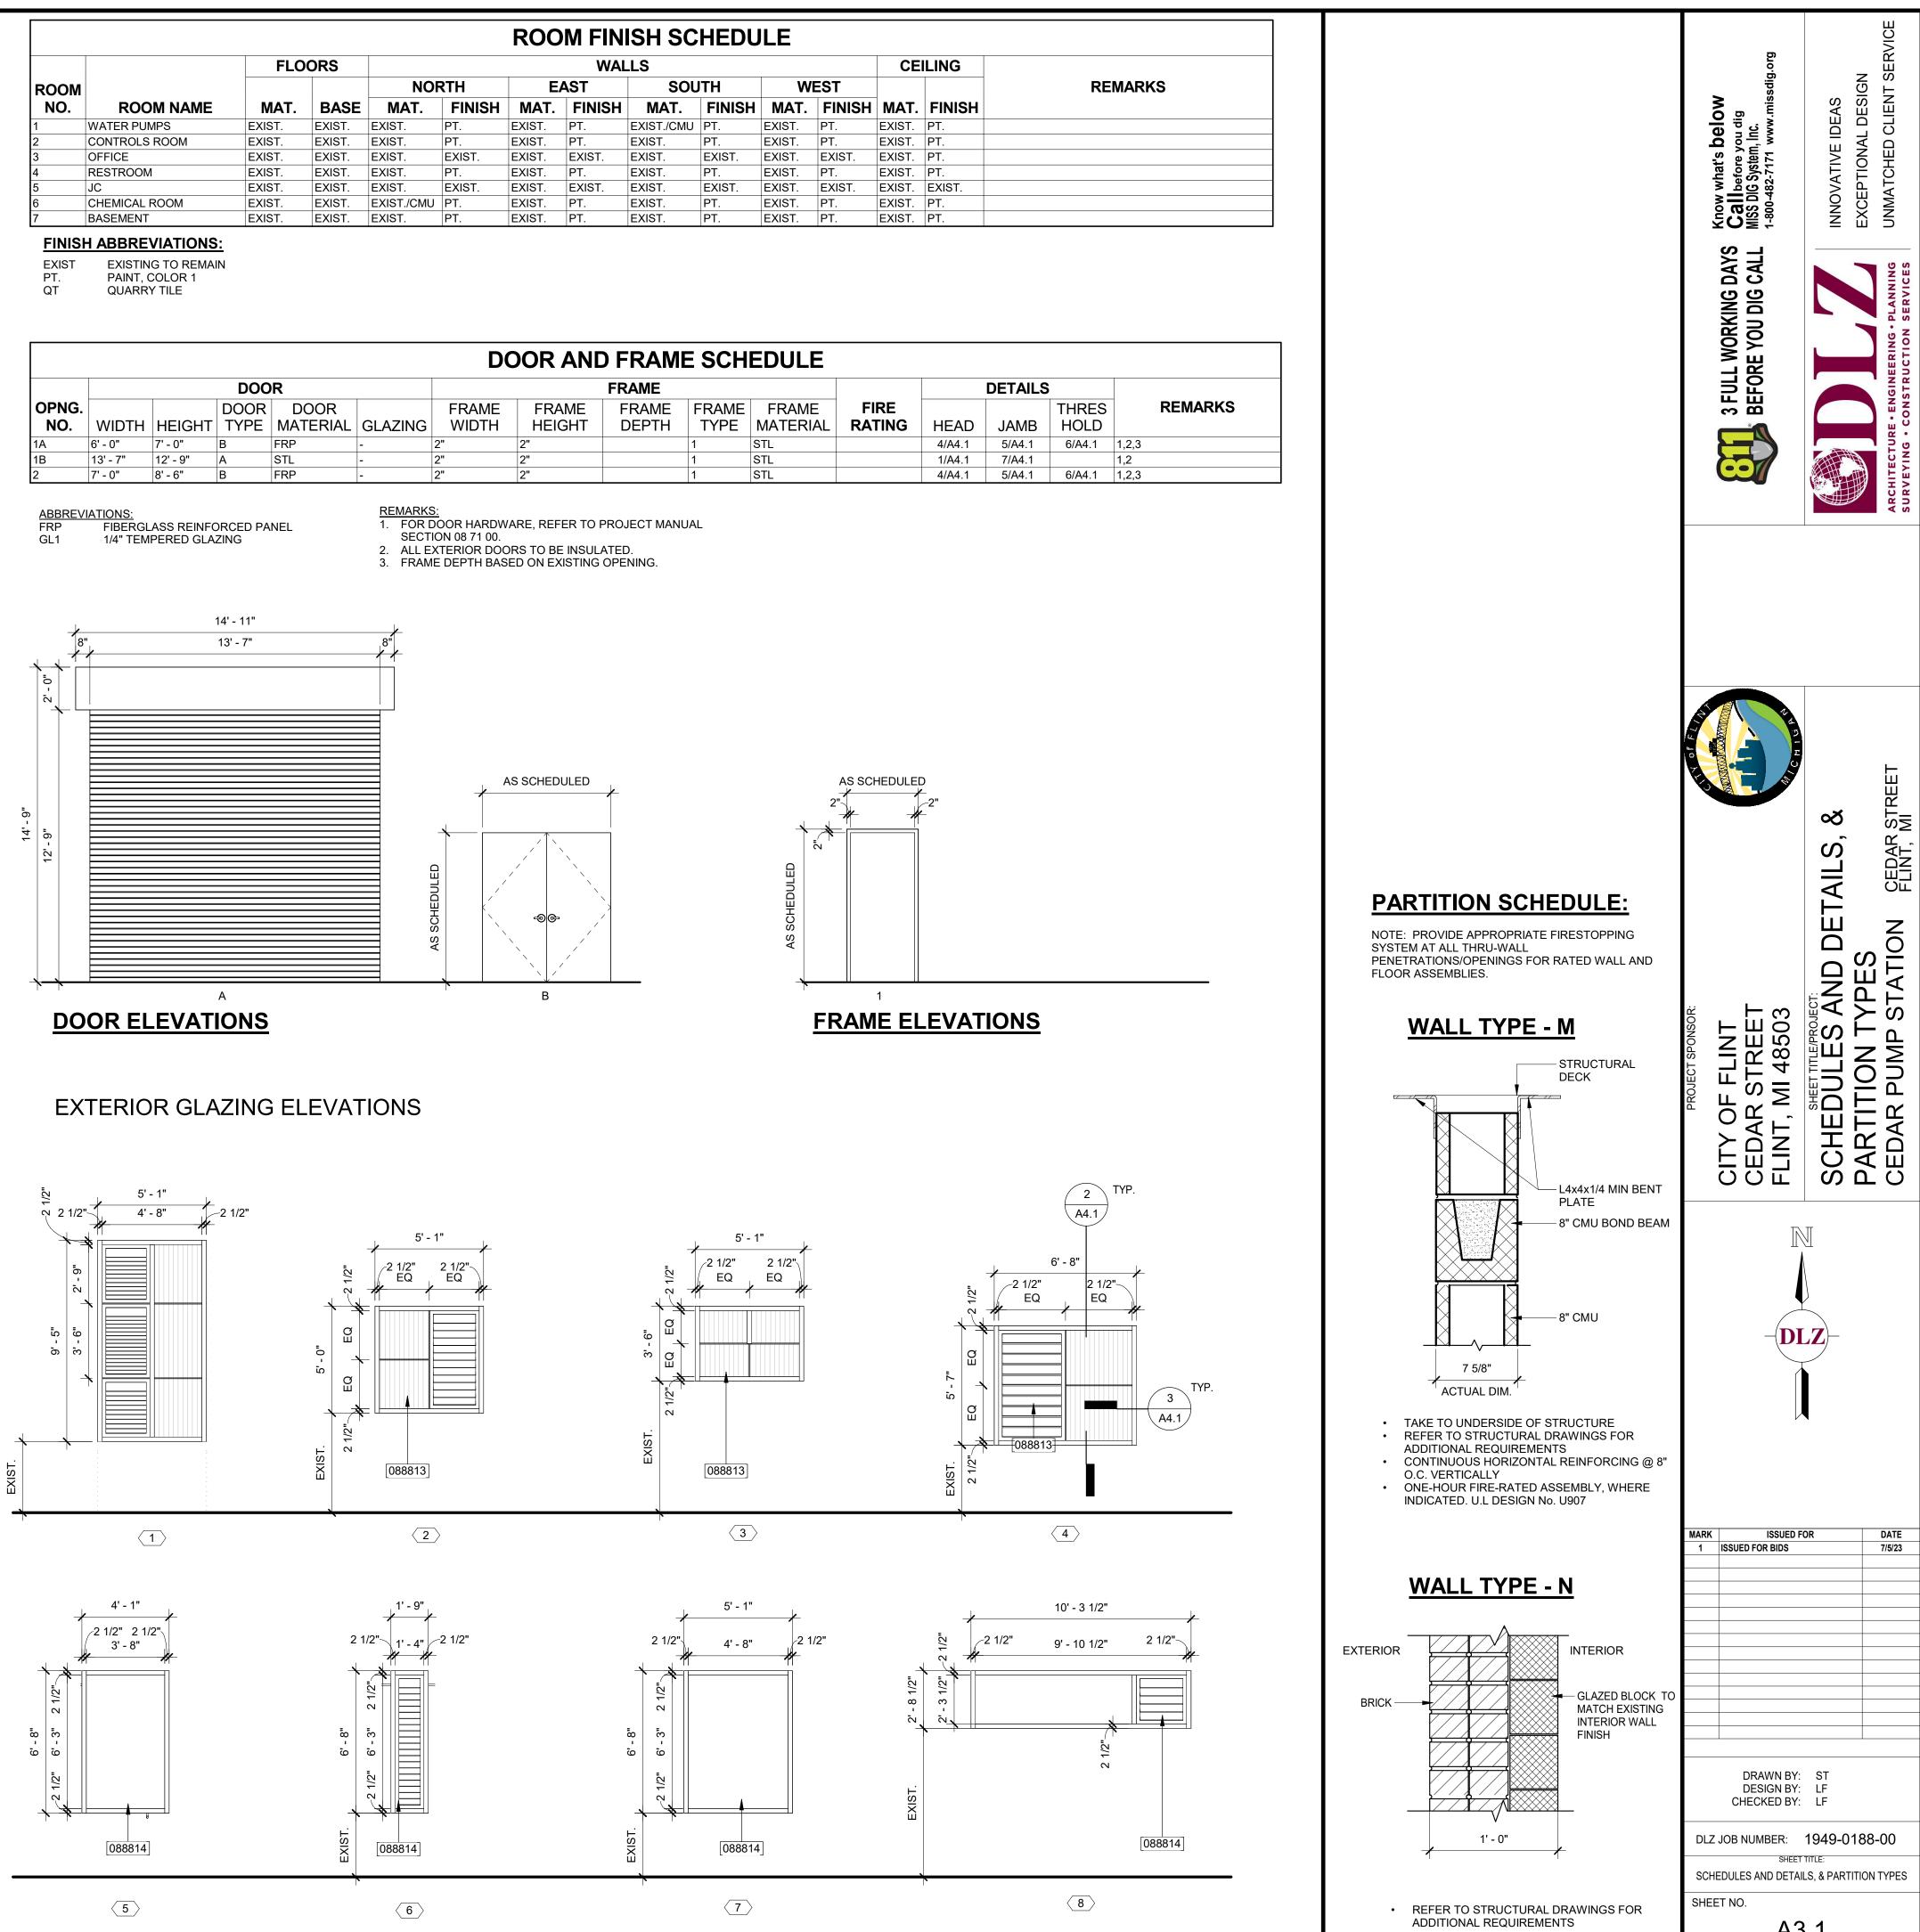

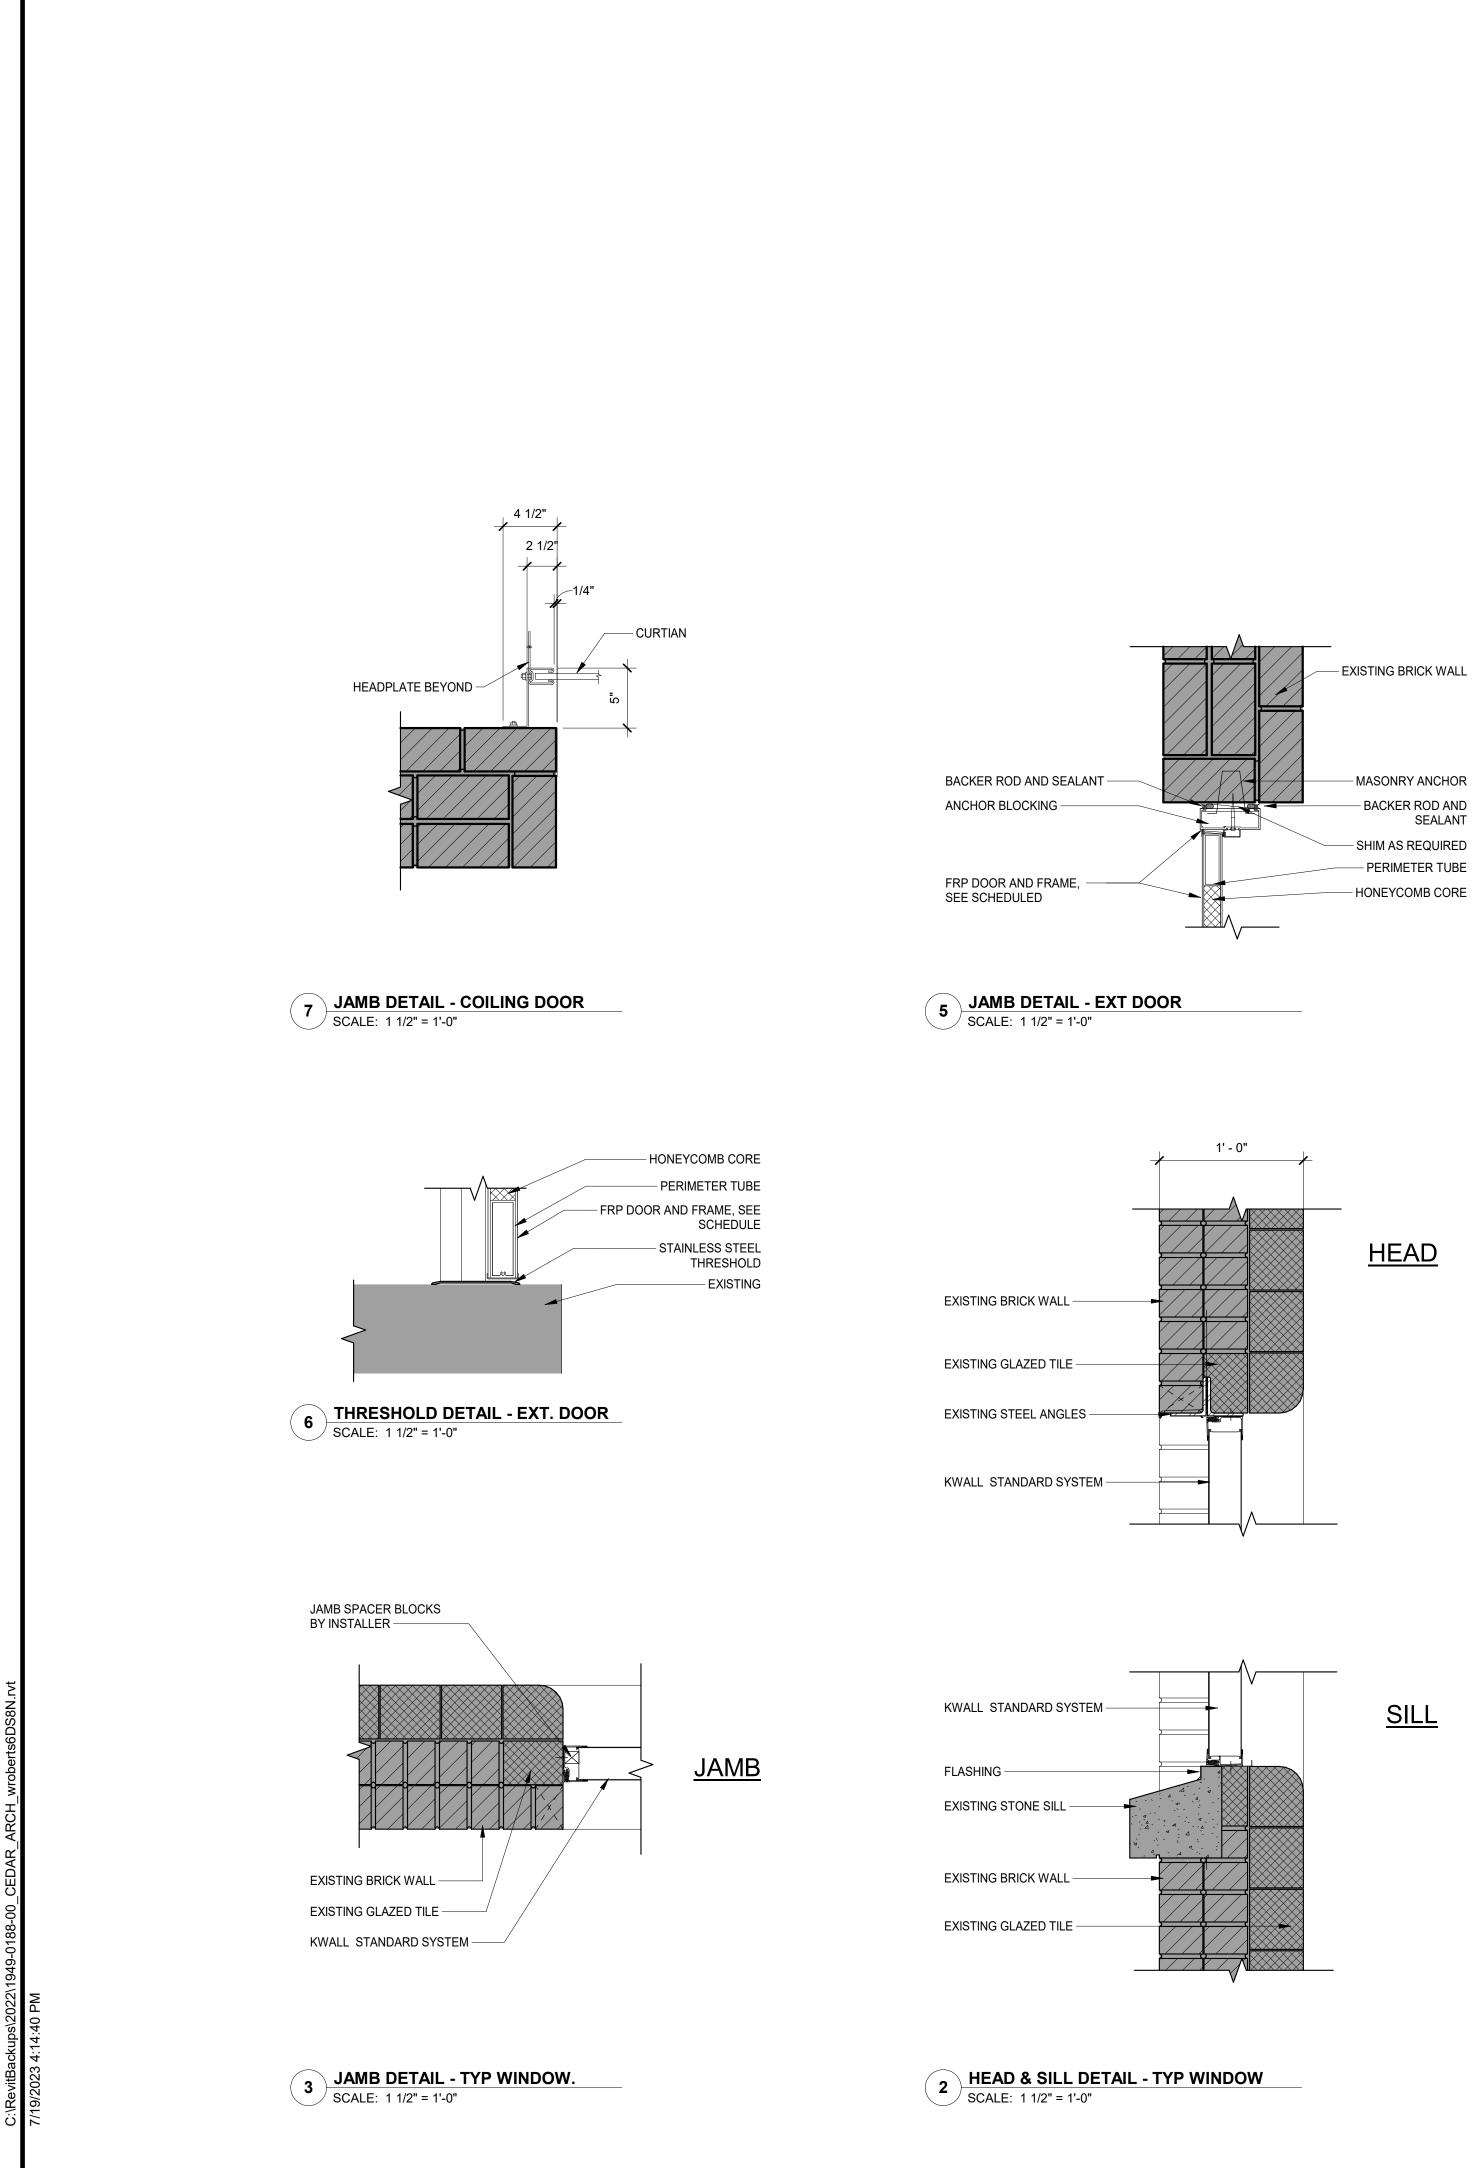

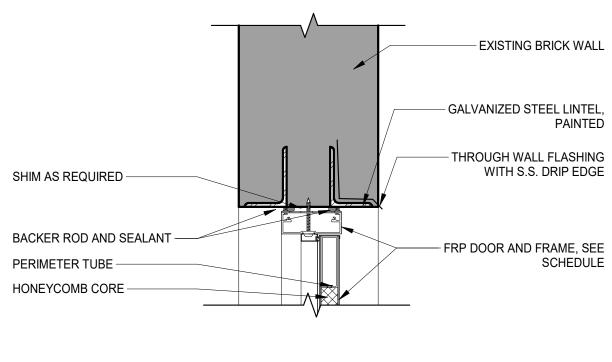

4 HEAD DETAIL - EXT DOOR SCALE: 1 1/2" = 1'-0"

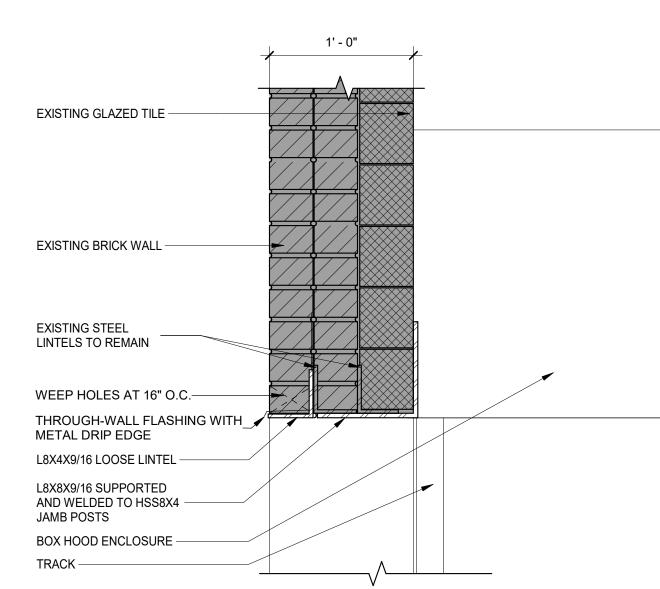


SUGGESTED SEQUENSEQUENCE OF INSTALLATION


1. DEMO WINDOW INFILL 2. DEMO MASONRY UNDER WINDOWS (LEAVE MASONRY BETWEEN WINDOWS) 3. INSTALL TUBE JAMBS


4. SAW CUT HORIZONTAL JOINT IN CENTER MASONRY WALL AND SLIDE NEW LINTEL INTO PLACE 5. DEMO CENTER MASONRY WALL AND EXTERIOR VENEER (VENEER FULL HEIGHT OF PARAPET)


6. INSTALL NEW BRICK LINTEL AND RECONSTRUCT VENEER


HEAD DETAIL - COILING DOOR SCALE: 1 1/2" = 1'-0"

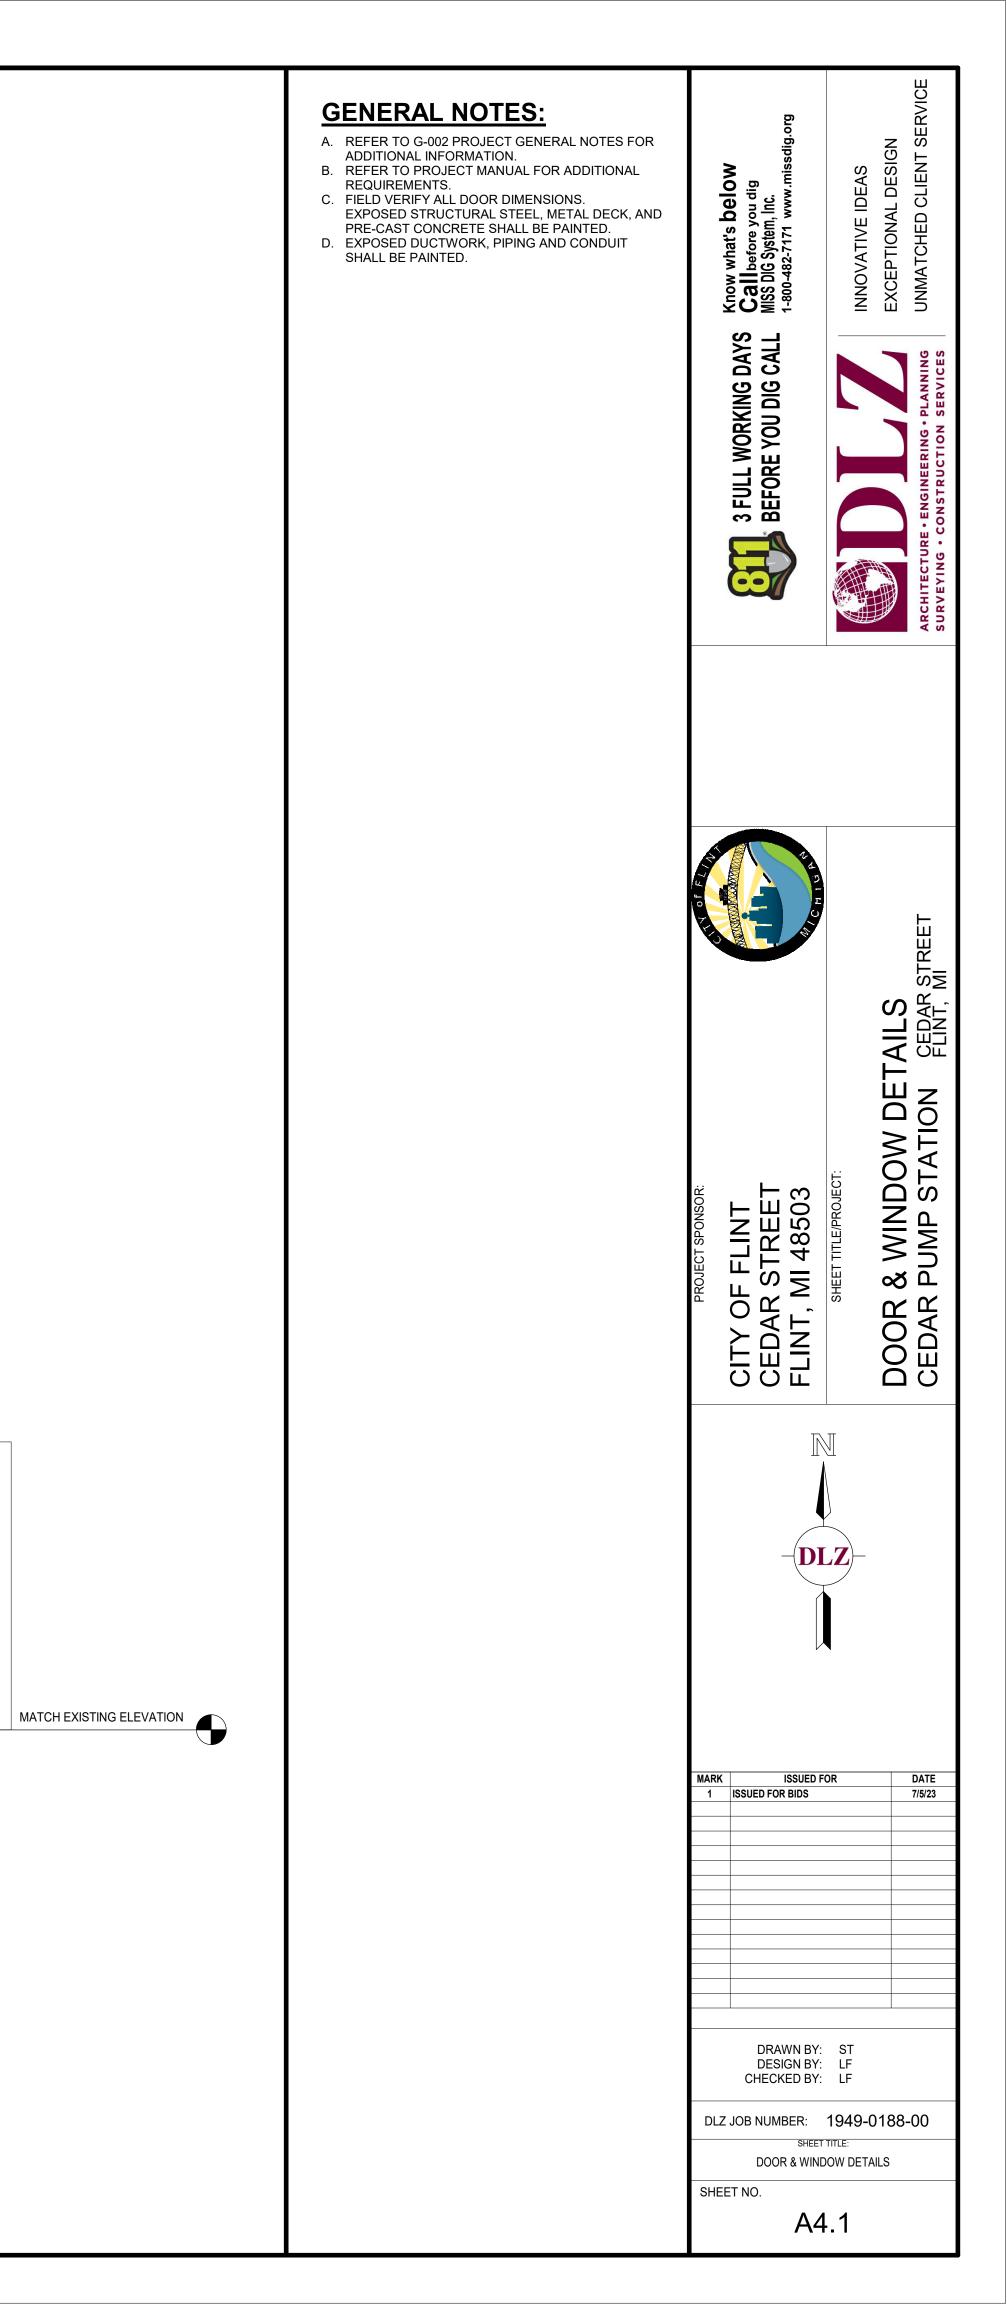

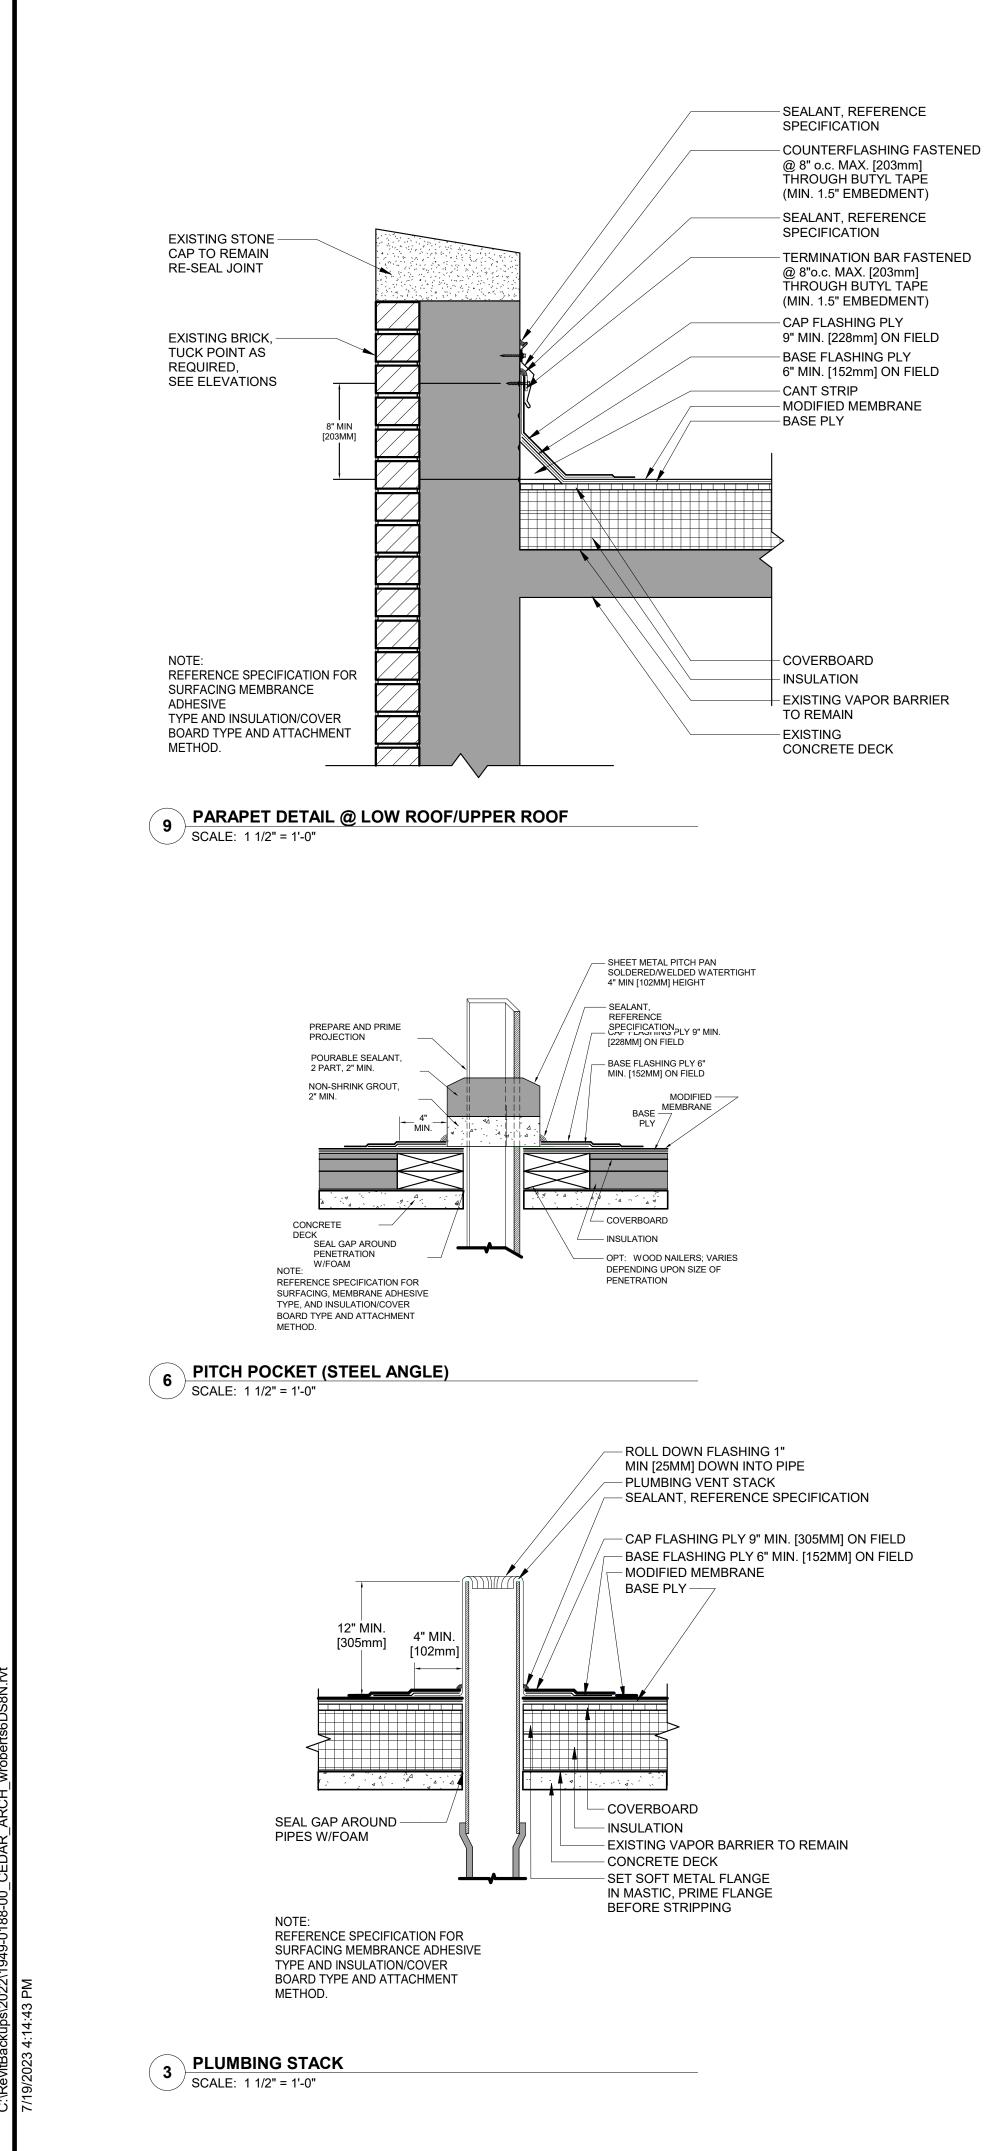

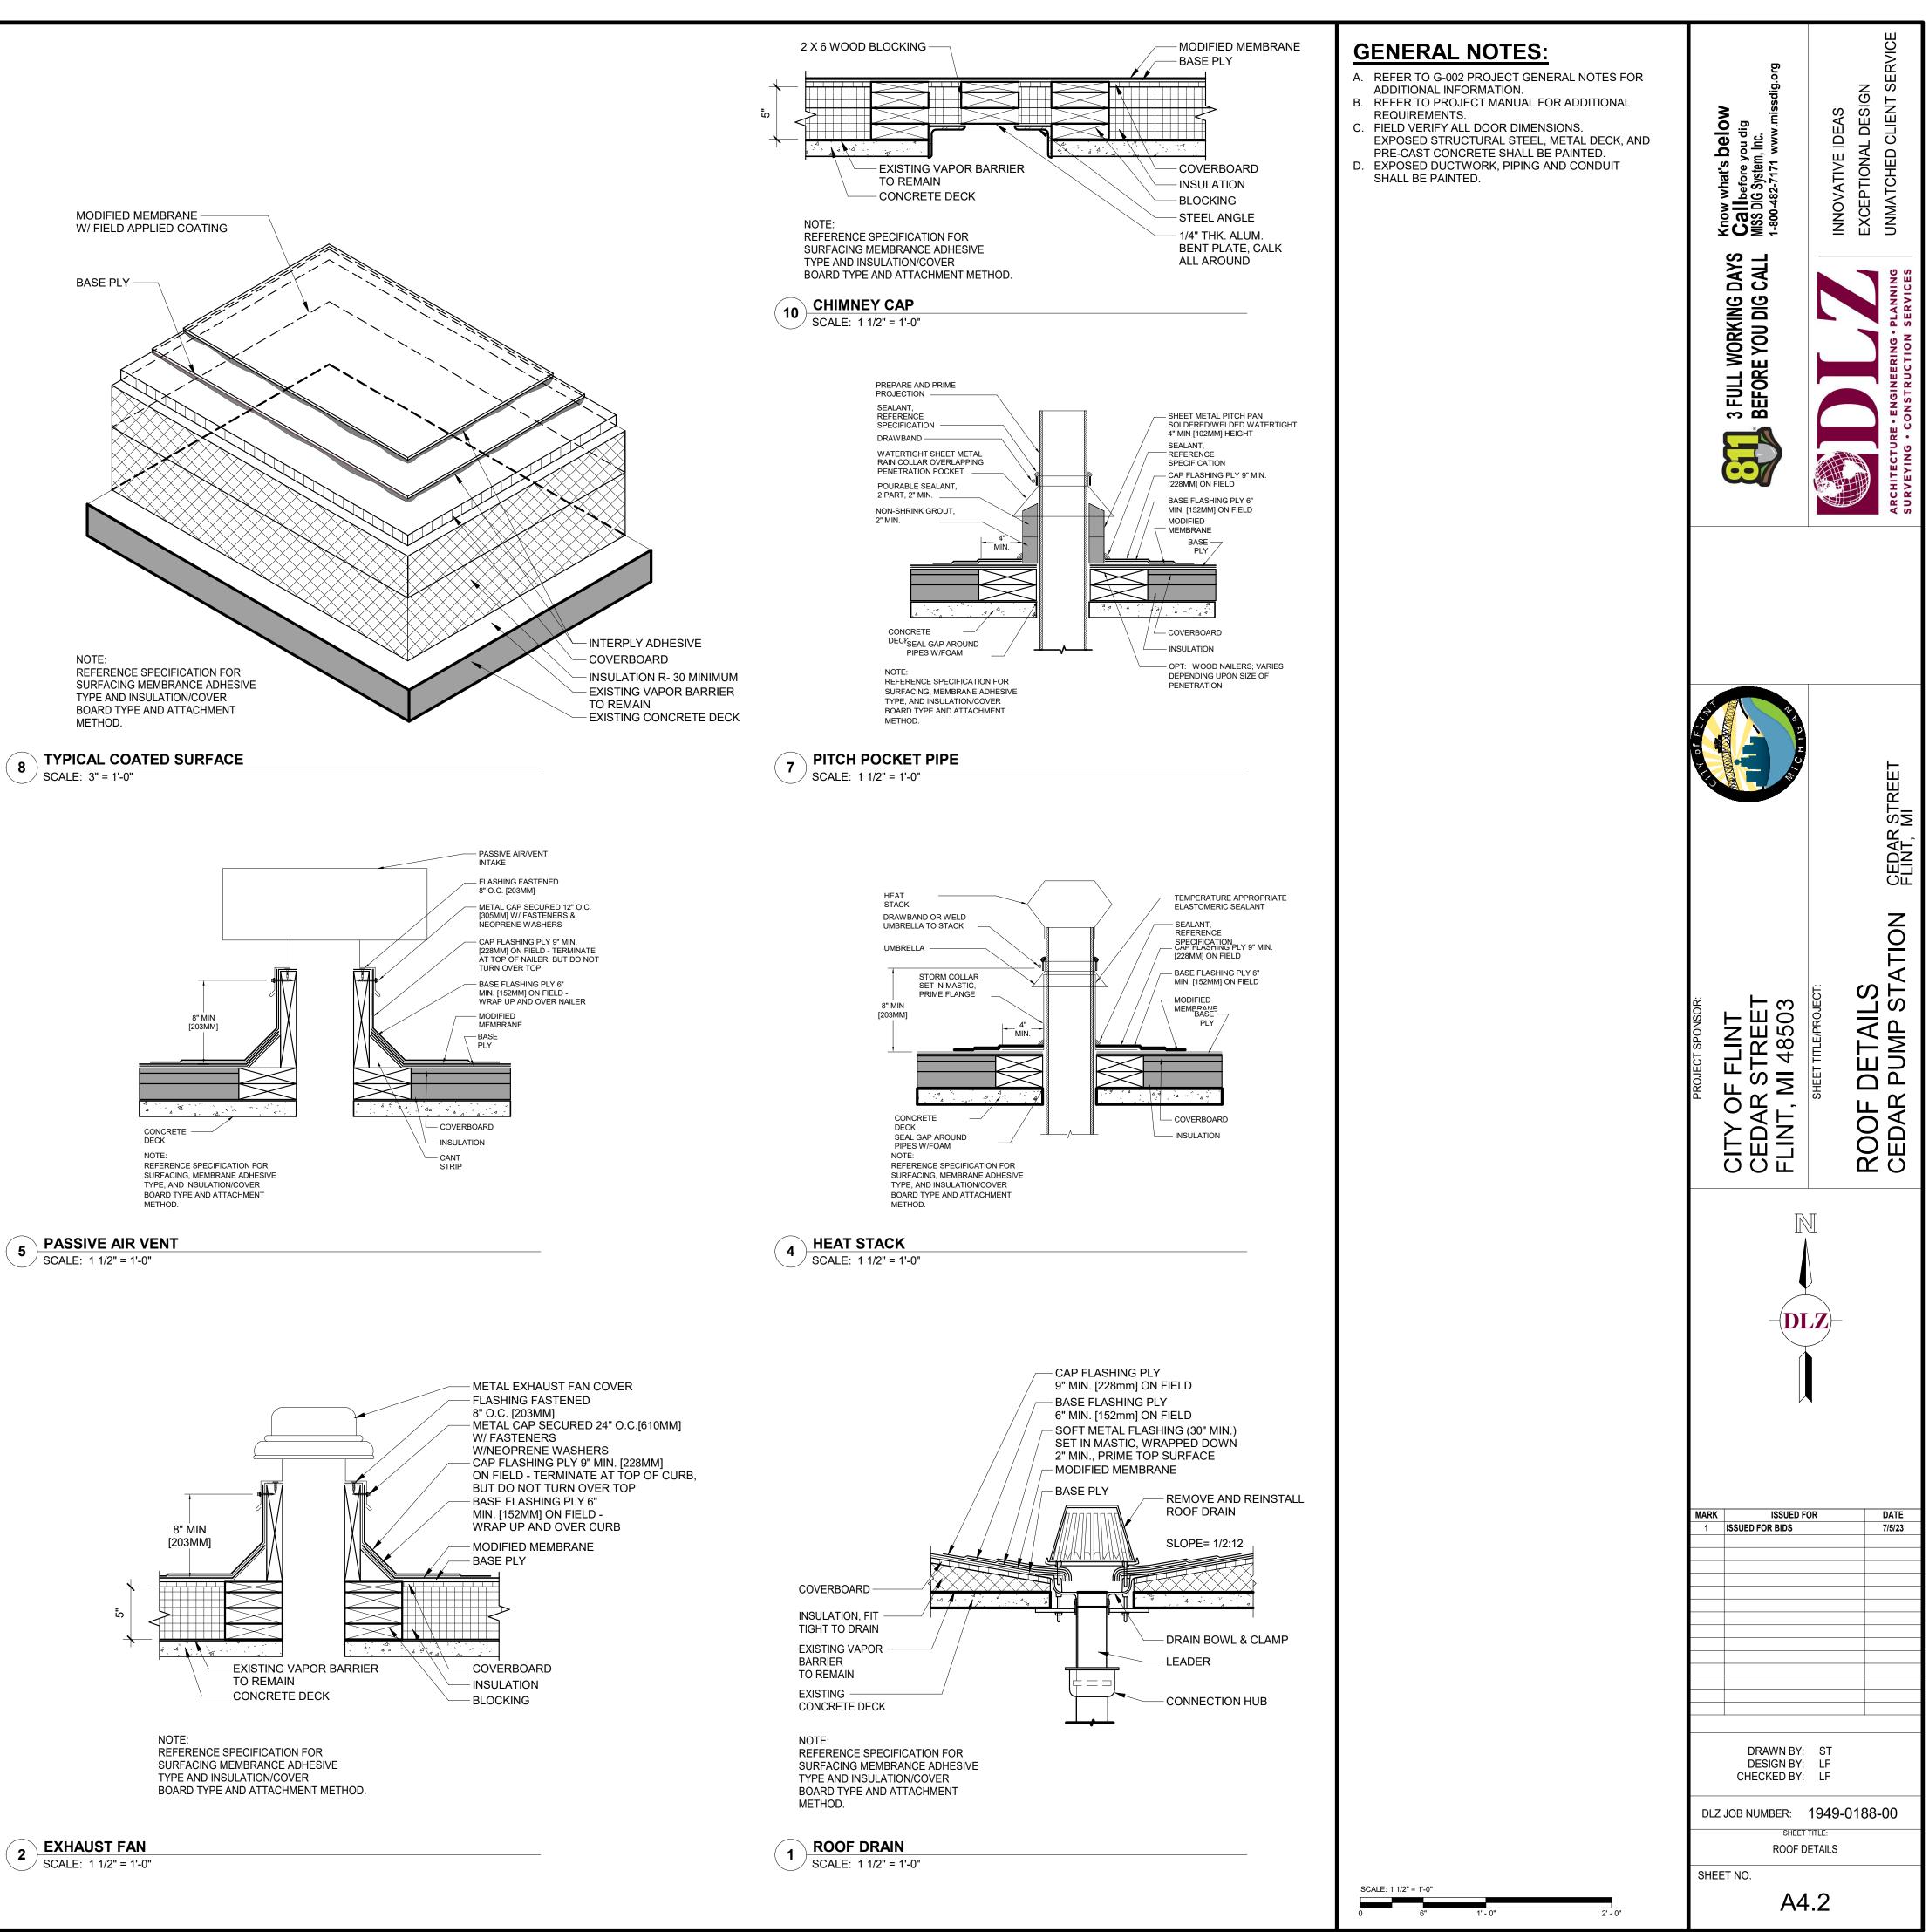

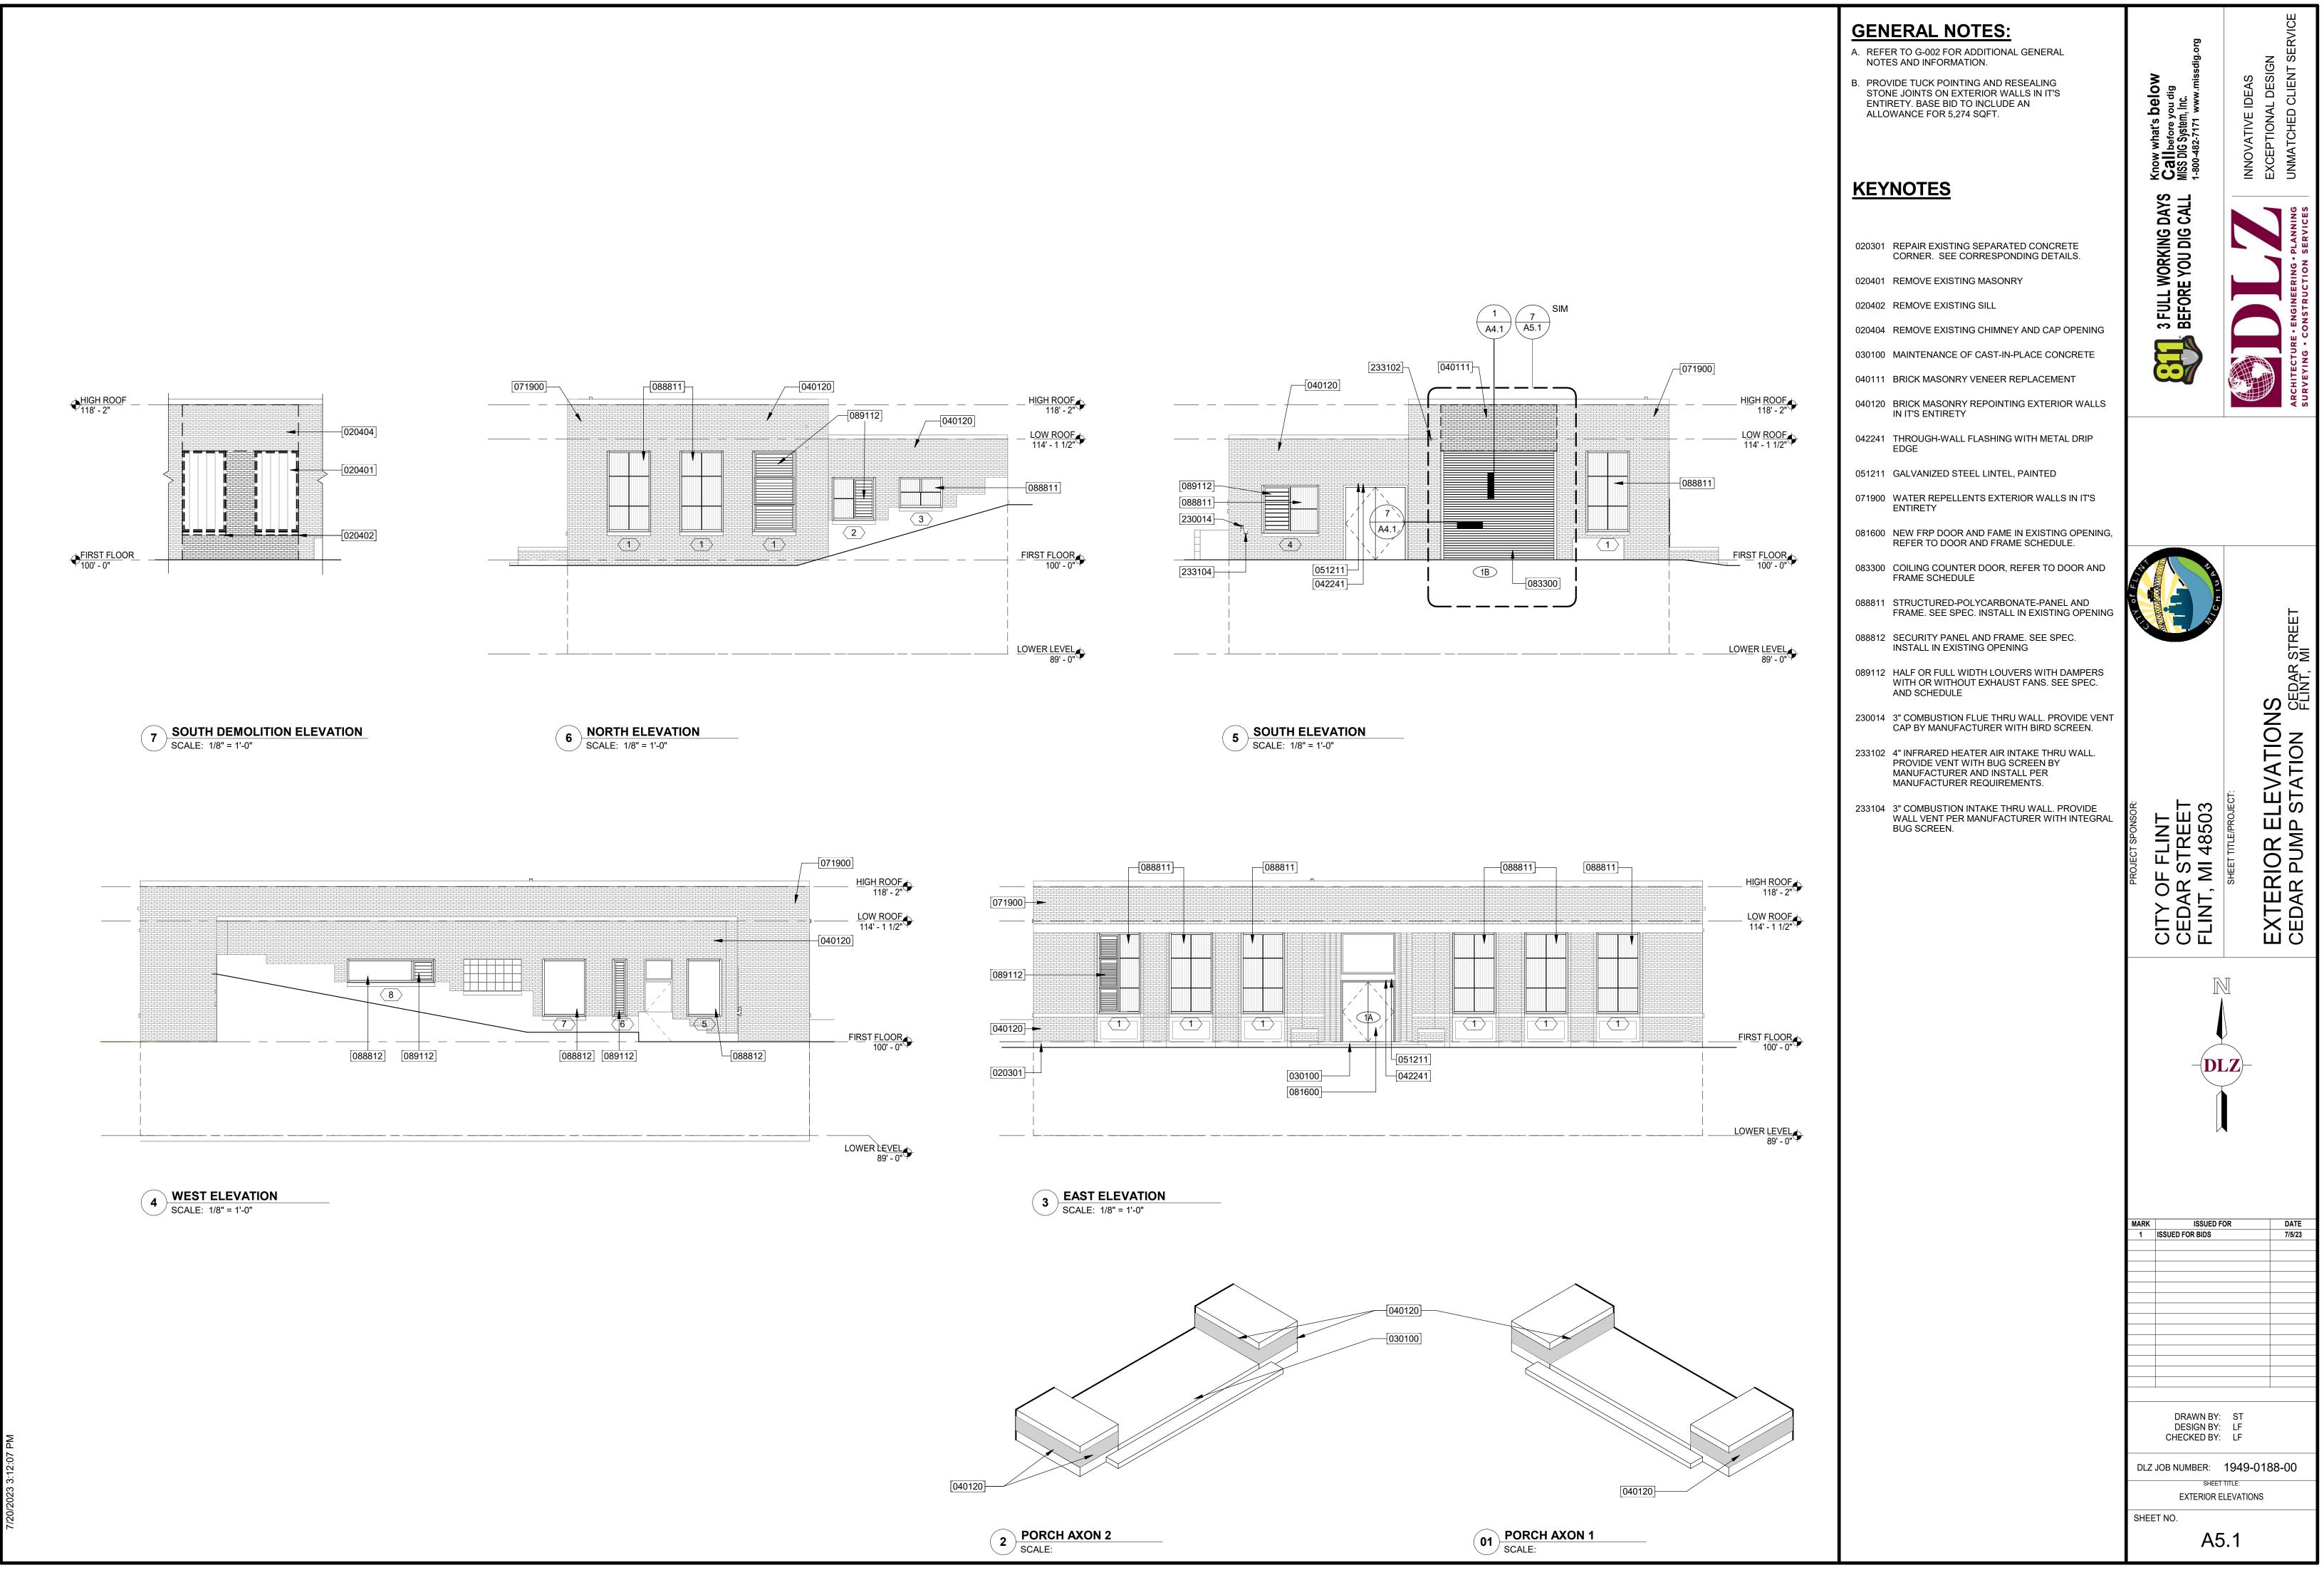

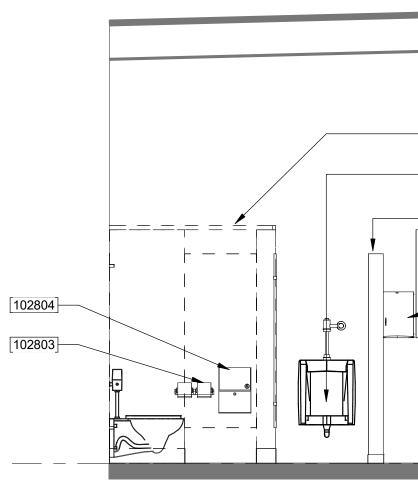

4 ENLARGED NEW WORK ELEVATION 1 SCALE: 3/8" = 1'-0"

